ITD DIST. 3 B3007 BLDG. IMPROVEMENT

8150 WEST CHINDEN BLVD

GARDEN CITY, ID

CONTACT INFORMATION

(NORMAL WEIGHT)

METAL, (LARGE SCALE DRAWING)

——— METAL, (SMALL SCALE DRAWING)

MOISTURE BARRIER

ASPHALT PAVING

IDAHO TRANSPORTATION DEPT 11331 WEST CHINDEN BLVD.

BOISE, IDAHO 83714

FAX (208) 334-3858

CONTACT: TONY PIRC

EMAIL: tony.pirc@itd.idaho.gov

MUSGROVE ENGINEERING, PA

234 S WHISPERWOOD WAY,

CONTACT: TODD NELSON

https://musgrovepa.com

EMAIL: toddn@musgrovepa.com

(208) 334-8600

itd.idaho.gov

(208) 384-0585

FAX (208) 384-0765

CSHQA 200 BROAD ST. BOISE, IDAHO 83702 FAX (208) 343-1858

EMAIL: james.marsh@CSHQA.com


AXIOM 121 N. 9TH ST. #401, CONTACT: JARED BRANDAU, PE, SE EMAIL: jbrandau@axiompllc.com

MUSGROVE ENGINEERING, PA 234 S WHISPERWOOD WAY. BOISE, ID 83709 (208) 384-0585 FAX (208) 384-0765 CONTACT: KURT LECHTENBERG

EMAIL: kurtl@musgrovepa.com

https://musgrovepa.com/

SITE LOCATION

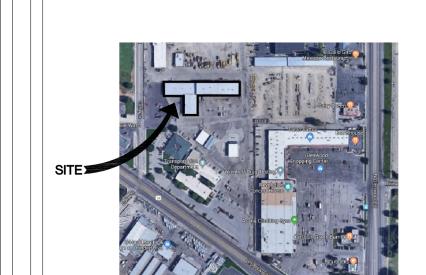

DRAWING INDEX

G00 TITLE SHEET

DEMO - ARCHITECTURAL AS21 DEMO PLAN ARCHITECTURE LEVEL 1 AS22 DEMO PLAN ARCHITECTURE LEVEL 2

S0.01 STRUCTURAL COVER SHEET

S0.02 GENERAL NOTES S1.02 LEVEL 2 FRAMING PLAN S1.03 ROOF FRAMING PLAN

S1.04 SECTIONS S1.05 CONCRETE DETAILS S1.06 ROOF DETAILS S1.07 ROOF DETAILS

S1.08 ROOF DETAILS

S1.09 STEEL DETAILS

ARCHITECTURAL A10 OVERALL PLANS **ROOF PLAN** EXTERIOR ELEVATIONS STAIR & CANOPY

A72 ELEVATOR DETAILS A79 STAIR DETAILS DOOR & WINDOW SCHEDULES

M00.1 MECHANICAL COVER SHEET M11.1 HVAC FIRST FLOOR PLAN M12.1 HVAC NEW FLOOR AND ROOF PLANS

E00.1 ELECTRICAL COVERSHEET E01.1 LIGHTING COMPLIANCE E21.1 ELECTRICAL DEMO FLOOR PLANS E31.1 ELECTRICAL FLOOR PLANS

ABBREVIATIONS PERPENDICULAR HEATING VENTIL ATING AND AIR DIAMETER NUMBER INSULATION EXISTING INTERIOR **JANITOR** RENOVATE OR RELOCATED KNOCKOUT AIR CONDITIONING A.D.A.A.C AMERICAN'S WITH DISABILITIES AC LOW POINT ABOVE FINISH FLOOR LAMINATE AIRLINES OPERATION ARE LAVATORY POUNDS MACHINE BOLT ACOUSTICAL ADJUSTABLE MASONRY OPENIN AGGREGATE **ALTERNATIVE** ALUMINUM MANUFACTURER MISCELLANEOUS BASE OF CURB NOT IN CONTRACT BUILT-UP NEAR SIDE BOARD NOT TO SCALE BUILDING NUMBER BLOCK NOMINAL OVER ALL ON CENTER CATCH BASIN OUTSIDE DIAMETER CENTER TO CENTER CAST IRON OPEN TO STRUCTURE CAST IN PLACE C.M.U. CONCRETE MASONRY UNIT OVERHEAD OFFICE COLD WATER OPENING OPPOSITE PLASTIC LAMINATE CUBIC FEET/MINUTE PAPER TOWEL DISPENSER PROPERTY LINE COUNTERSUNK PARTICLE PLATE PLUMBING CONCRETE PLYWOOD CONTINUOUS PRE-ENGINEERED CORRIDOR COORDINATE WITH PAVEMENT QUARRY TILE DEFORMED BAR ANCHOR RADIUS OR RISER ROOF DRAIN DRY STANDPIPE ROUGH OPENING RAIN WATER LEADER REFERENCE (CW/) DIAMETER DIAGONAL DIMENSION SOLID CORE EXPANSION BOI T SEAT COVER DISPENSER **EXTERIOR INSULATION & FINISHING SYSTEM** SOAP DISPENSER SQUARE FEET OR FOO EXPANSION JOINT ELECTRICAL PANELBOARD S.N.D. ELECTRIC WATER COOLER SANITARY NAPKIN RECEPTACLE STAINLESS STEEL SCHEDULE **ELEVATOR** SECTION SHOWER EQUIPMENT EXHAUST **SPECIFICATIONS EXPANSION** SQUARE **EXTERIOR** STREET OR STEEL FIRE ALARM STANDARD STRUCTURAL FLOOR DRAIN SUSPENDED FIRE EXTINGUISHER FIRE EXTINGUISHER CABINE FIRE HOSE CABINET FACE OF TOWEL BAR FACE OF CURB/CONCRETE TOP OF DRAIN TOP OF CURB/CONCRETI TOP OF MASONRY FACE OF TREAD TOP OF PARAPET FAR SIDE FOUNDATION T.O.W. T.P.D. TOILET PAPER DISPENSER FLOOR(ING) TELEPHONE FOOT OR FEET THICKNESS THRESHOLD FIRE TREATED WOOD **FURRING** V.C.T. GRAB BAR VERIFY IN FIELD GAUGE OR GAGE VENTILATION GALVANIZED VERTICAL VESTIBULE HEADED ANCHOR STUD WALL BEYOND H.A.S. HEADED CONCRETE ANCHOR HOSE BIBB HANDICAPPED - A.D.A.A.C WIRE GLASS HOLLOW METAL WORK POINT WASTE RECEPTACLE HOT WATER

W.W.F.

WELDED WIRE FABRIC

HORIZONTAL

HOUR

GENERAL NOTES

THE APPLICABLE BUILDING CODE IS THE 2018 INTERNATIONAL BUILDING CODE (2018 IBC) THE DRAWINGS INDICATE LOCATION, DIMENSIONS, REFERENCE, AND TYPICAL DETAILS OF CONSTRUCTION. THE DRAWINGS DO

PARTITION DIMENSIONS ARE GIVEN TO THE FACE OF STUD UNLESS OTHERWISE NOTED DOOR OPENING LOCATIONS ARE DIMENSIONED TO ROUGH OPENING OR CENTERLINE OF OPENING

THAT DISTURB 260 L.F. /160 SQ. FT. /35 CU. FT. OF ASBESTOS CONTAINING MATERIALS.

ALL NEW CONSTRUCTION TO COMPLY WITH THE AMERICANS WITH DISABILITIES ACT ACCESSIBILITY GUIDELINES (A.D.A.A.G.) ICC/ANSI A117.1-2010 (2018 IBC SECTION 1101).

THERWISE INDICATED ALL DRAWINGS, NOTES WHICH DO NOT READ "N.I.C.", "EXISTING", OR "EXISTING TO REMAIN", OR

THE CONTRACTOR(S) SHALL KEEP ALL AREAS OF CONSTRUCTION CLEAN AND FREE OF DEBRIS. AFTER CONSTRUCTION IS COMPLETE. THE GENERAL CONTRACTOR SHALL PROVIDE FINAL CLEAN UP. THE CONTRACTOR SHALL VERIFY ALL EXISTING CONDITIONS AND DIMENSIONS FOR ACCURACY PRIOR TO COMMENCING WITH THE WORK. ANY DISCREPANCY SHALL BE BROUGHT TO THE ATTENTION OF THE ARCHITECT.

PENETRATIONS THROUGH RATED ASSEMBLIES SHALL BE FIRE STOPPED IN ACCORDANCE WITH 2018 IBC SECTION 714.4.1 AND

714.4.1.2. PROVIDE A FIRESTOPPING SYSTEM APPROPRIATE FOR THE WORK BEING PERFORMED. PAINTABLE SEALANT SHALL BE PROVIDED AT ALL EXPOSED AREAS. PROVIDE COPIES OF THE SPECIFIC FIRE-STOP SYSTEMS PROPOSED FOR USE IN THIS PROJECT AT PENETRATIONS OF ONE-HOUR WALLS OR TWO-HOUR SHAFTS AND FLOOR ASSEMBLIES. FOR APPROVAL AND INSPECTION USE BY THE FIRE AND STRUCTURAL INSPECTORS. ASSEMBLIES SHALL SHOW ALL REQUIRED COMPONENTS AND METHOD OF INSTALLATION TO PROVIDE THE REQUIRED FIRE-STOP RATINGS AS SYSTEM BEING PENETRATED. THIS SPACE MAY NOT BE OCCUPIED UNTIL IT RECEIVES A CERTIFICATE OF OCCUPANCY AND FIRE DEPARTMENT APPROVAL.

CONTRACTOR SHALL NOT CORE DRILL WITHOUT VERIFYING LOCATION OF CONCRETE REINFORCING. THE CONTRACTOR IS RESPONSIBLE FOR ALL PERMITS AND FEES NECESSARY TO EXECUTE THE INTENT OF THESE

EXIT SIGNAGE SHALL BE EXTERNALLY OR INTERNALLY ILLUMINATED BY THE PREMISES' WIRING, STORAGE BATTERIES AND, BE IN COMPLIANCE WITH 2018 IBC SECTION 1013. PROVIDE BLOCKING AS REQUIRED FOR ALL AREAS TO RECEIVE MILLWORK AND WALL-ATTACHED ITEMS AS SHOWN IN PLANS. ALL EXITS SHALL BE OPENABLE FROM THE INSIDE WITHOUT THE USE OF A KEY OR ANY SPECIAL KNOWLEDGE OR EFFORT. 2018

EXIT WAYS SHALL BE ILLUMINATED. THE POWER SUPPLY FOR EXIT ILLUMINATION SHALL NORMALLY BE PROVIDED BY THE PREMISES' WIRING SYSTEM, 2018 IBC SECTION 1008.

COORDINATE MECHANICAL AND ELECTRICAL REQUIREMENTS, ROUTING, AND FIELD VERIFICATION. WHERE NEW CONSTRUCTION JOINS WITH EXISTING CONSTRUCTION, ALIGN FINISHED SURFACE OF NEW CONSTRUCTION WITH

PROVIDE COPY OF FIRE-RESISTANCE RATING ASSEMBLIES TO THE STRUCTURAL INSPECTOR FOR VERIFICATION OF

TESTING/LISTING COMPLIANCE AND TO INSPECT ASSEMBLY CONSTRUCTION THEREWITH. COORDINATE CONSTRUCTION ACTIVITIES WITH OWNER. FIRE SPRINKLER AND ALARM MODIFICATIONS REQUIRE SEPARATE APPLICATION AND PLAN SUBMITTALS PRIOR TO PERFORMING WORK. ALL LIFE-SAFETY FEATURES SHALL BE APPROVED BY THE FIRE AND STRUCTURAL INSPECTORS PRIOR TO OCCUPANCY.

ALL CONSTRUCTION ADDENDA, CHANGE ORDERS, OR DESIGN CLARIFICATIONS TO THOSE ITEMS REGULATED BY THE CODES MUST BE SUBMITTED TO THE FIELD INSPECTOR FOR REVIEW AND APPROVAL PRIOR TO COMMENCING WITH ANY OF THE PROPOSED WORK RELATED TO THE PROPOSED FIELD CHANGE.

SUSPENDED CEILING SYSTEMS TO BE INSTALLED IN ACCORDANCE WITH 2018 IBC SECTION 808.1.1.1 AND ASTM C 635 AND ASTM C

ALL INSULATION MATERIALS SHALL COMPLY WITH 2018 IBC SECTION 720. HANDLES, PULLS, LATCHES, LOCKS, AND OTHER OPERABLE PARTS ON ACCESSIBLE DOORS SHALL HAVE A SHAPE THAT IS EASY

TO GRASP WITH ONE HAND AND DOES NOT REQUIRE TIGHT GRASPING, PINCHING, OR TWISTING OF THE WRIST TO OPERATE. SUCH HARDWARE SHALL BE AT 34" MINIMUM AND 48" MAXIMUM ABOVE THE FLOOR OR GROUND. **2018 IBC SECTION 1010.1.9**. COMBUSTIBLE MATERIALS SHALL NOT BE USED IN CONCEALED SPACES UNLESS EVIDENCE OF COMPLIANCE WITH 2018 IBC SECTION 717.5 IS PROVIDED TO THE STRUCTURAL INSPECTOR FOR REVIEW AND APPROVAL

DECORATIVE MATERIALS AND TRIM SHALL BE RESTRICTED BY COMBUSTIBILITY AND THE FLAME PROPAGATION PERFORMANCE CRITERIA OF NFPA 701, IN ACCORDANCE WITH 2018 IBC SECTION 806. CONTRACTOR SHALL HAVE CERTIFICATE OF COMPLIANCE FOR DECORATIVE MATERIALS AND TRIM, INDICATING COMPLIANCE WITH THIS CODE SECTION AS APPLICABLE TO THIS PROJECT CONTRACTOR SHALL HAVE AVAILABLE AT THE JOB SITE EVIDENCE OF CODE COMPLIANCE OF RATING OF WALL AND CEILING

FINISH MATERIALS AT CONSTRUCTION SITE FOR REVIEW BY FIRE AND STRUCTURAL FIELD INSPECTORS IN ACCORDANCE WITH 2018 IBC SECTION 803 AND TABLE 803.13.

ACCESS TO MECHANICAL APPLIANCES INSTALLED IN UNDER-FLOOR AREAS, IN ATTIC SPACES AND ON ROOFS OR ELEVATED STRUCTURES SHALL BE IN ACCORDANCE WITH THE INTERNATIONAL MECHANICAL CODE. CONTROLS, OPERATING MECHANISMS AND HARDWARE INTENDED FOR OPERATION BY THE OCCUPANT, INCLUDING SWITCHES

THAT CONTROL LIGHTING AND ACCESSIBLE. VENTILATION AND EXHAUST SYSTEMS SHALL BE PROVIDED AS REQUIRED BY THE INTERNATIONAL MECHANICAL CODE AND THE INTERNATIONAL FIRE CODE.

 $\overline{}$

DEFERRED SUBMITTALS

FIRE SPRINKLER SHOP DRAWINGS

MATERIALS & SYMBOLS

WINDOW TYPE, RE: A82 WINDOW TYPES POROUS FILL - GRAVEL DOOR NUMBER, RE: A82 DOOR SCHEDULE MATERIAL FINISH, RE: A81 & I81 FINISH SCHEDULE RELATED SPECIFICATION DIVISION RELATED SPECIFICATION SECTION SHEET NOTE, RE: SHEET NOTES LIST

ON CURRENT PAGE FOR WALL TYPES WITH VARIABLE HEIGHT,

ACCESSORY/FIXTURE TYPE, RE: A42

SEE TOP OF WALL ELEVATION

REVISION KEY RE: REVISED BOX IN TITLE BLOCK OF CURRENT PAGE

TRENCH DRAIN

--- -- PROPERTY LINE

FRAMING LUMBER — - - — SWALE/FLOW LINE

AREA DRAIN / CATCH BASIN PARTICLE BOARD

FLUSH SURFACE MEETING FINISH LUMBER — — BUILDING GRID LINE

GYPSUM BOARD —— – STRUCTURE CENTERLINE ACOUSTIC TILE/PANEL

ELEVATION POINT BATT INSULATION DRAWING MATCH LINE

OCCUPANTS

OCCUPANCY

FACTOR

SEMI-RIGID INSULATION BUILDING SECTION MARK REF. RIGID INSULATION (SEE DWG. #1 @ SHT. A61)

DETAIL REFERENCE

WALL SECTION MARK REF (SEE DWG. #1 @ SHT. A63)

(SEE DWG. #1 @ SHT. A71) DETAIL SECTION MARK AX.XX-X



INTERIOR ELEVATIONS SEE DWG. #1 @ SHT. I51, I52, I53

ROOM NUMBER

ACCESSORY USE 150 SF/

→ AREA OF ROOM

PROJECT DESCRIPTION

SCOPE OF WORK INCLUDES BUILDING IMPROVEMENTS AND NEW DISTRICT 3 CAMPUS. THE PURPOSE IS TO PREPARE THE BUILDING TO HAVE ACCESS TO THE SECOND FLOOR FOR POSSIBLE TENANT IMPROVEMENTS IN THE FUTURE.

THE WORK INCLUDES:

RELOCATION OF AN EXISTING STAIRWAY NEW EXTERIOR DOOR AND LANDING INFILL TO

ACCOMMODATE RELOCATED STAIRWAY NEW STAIRWAY AT BUILDING ENTRY NEW CANOPY AT BUILDING ENTRY REPLACE EXISTING CONVEYING SYSTEM WITH NEW

SLAB AND ROOF TO ACCOMMODATE ELEVATOR SHAFT REQUIREMENTS PER MFG. NEW DOOR AT EXITING FIRST LEVEL LOBBY

PRIOR TO OCCUPANCY, A FIRE SPRINKLER SYSTEM WILL

ELEVATOR. THIS INCLUDES DEMOLITION OF EXISTING

CODE DATA

CODE REFERENCES ARE THOSE CURRENTLY ADOPTED BY CITY

2018 INTERNATIONAL BUILDING CODE (IBC) 2018 INTERNATIONAL ENERGY CONSERVATION CODE (IECC)
2017 IDAHO STATE PLUMBING CODE 2018-INTERNATIONAL MECHANICAL CODE (IMC)

2018 INTERNATIONAL FUEL GAS CODE (IFGC) 2017 NATIONAL ELECTRICAL CODE (NEC) 2018 INTERNATIONAL EXISTING BUILDING CODE (IEBC) **2018 IEBC COMPLIANCE PATH:** OPTION 2: WORK FOR ALTERATION, CHANGE OF OCCUPANCY OR ADDITION OF ALL

EXISTING BUILDINGS SHALL BE DONE IN ACCORDANCE WITH THE WORK AREA COMPLIANCE METHOD GIVEN IN CHAPTERS 6 THROUGH 12.

PROJECT ADDRESS: RELOCATE 2

8150 WEST CHINDEN BOULEVARD VEHICLE MAINTENANCE AND

(NO CHANGE)

CONSTRUCTION TYPE: III- B (NO CHANGE) **OCCUPANCY GROUP:** F1 (EXISTING) NUMBER OF STORIES: 2 (NO CHANGE)

BUILDING AREA: 34.165 SF (NO CHANGE) NO (FUTURE WITH TENANT FIRE SPRINKLER:

IMPROVEMENT) OCCUPANCY LOADING: 110 (NO CHANGE) 1 BUILDING

IMPROVEMENT PERMIT SET

PROJECT 10-30-23 DRAWN CHECKED LB

03/27/24

05/16/24


REVISED E_BACK CHECK 1 Addendum 02

SHEET TITLE

TITLE SHEET

SHEET

ORIGINAL SHEET SIZE 24" x 36"

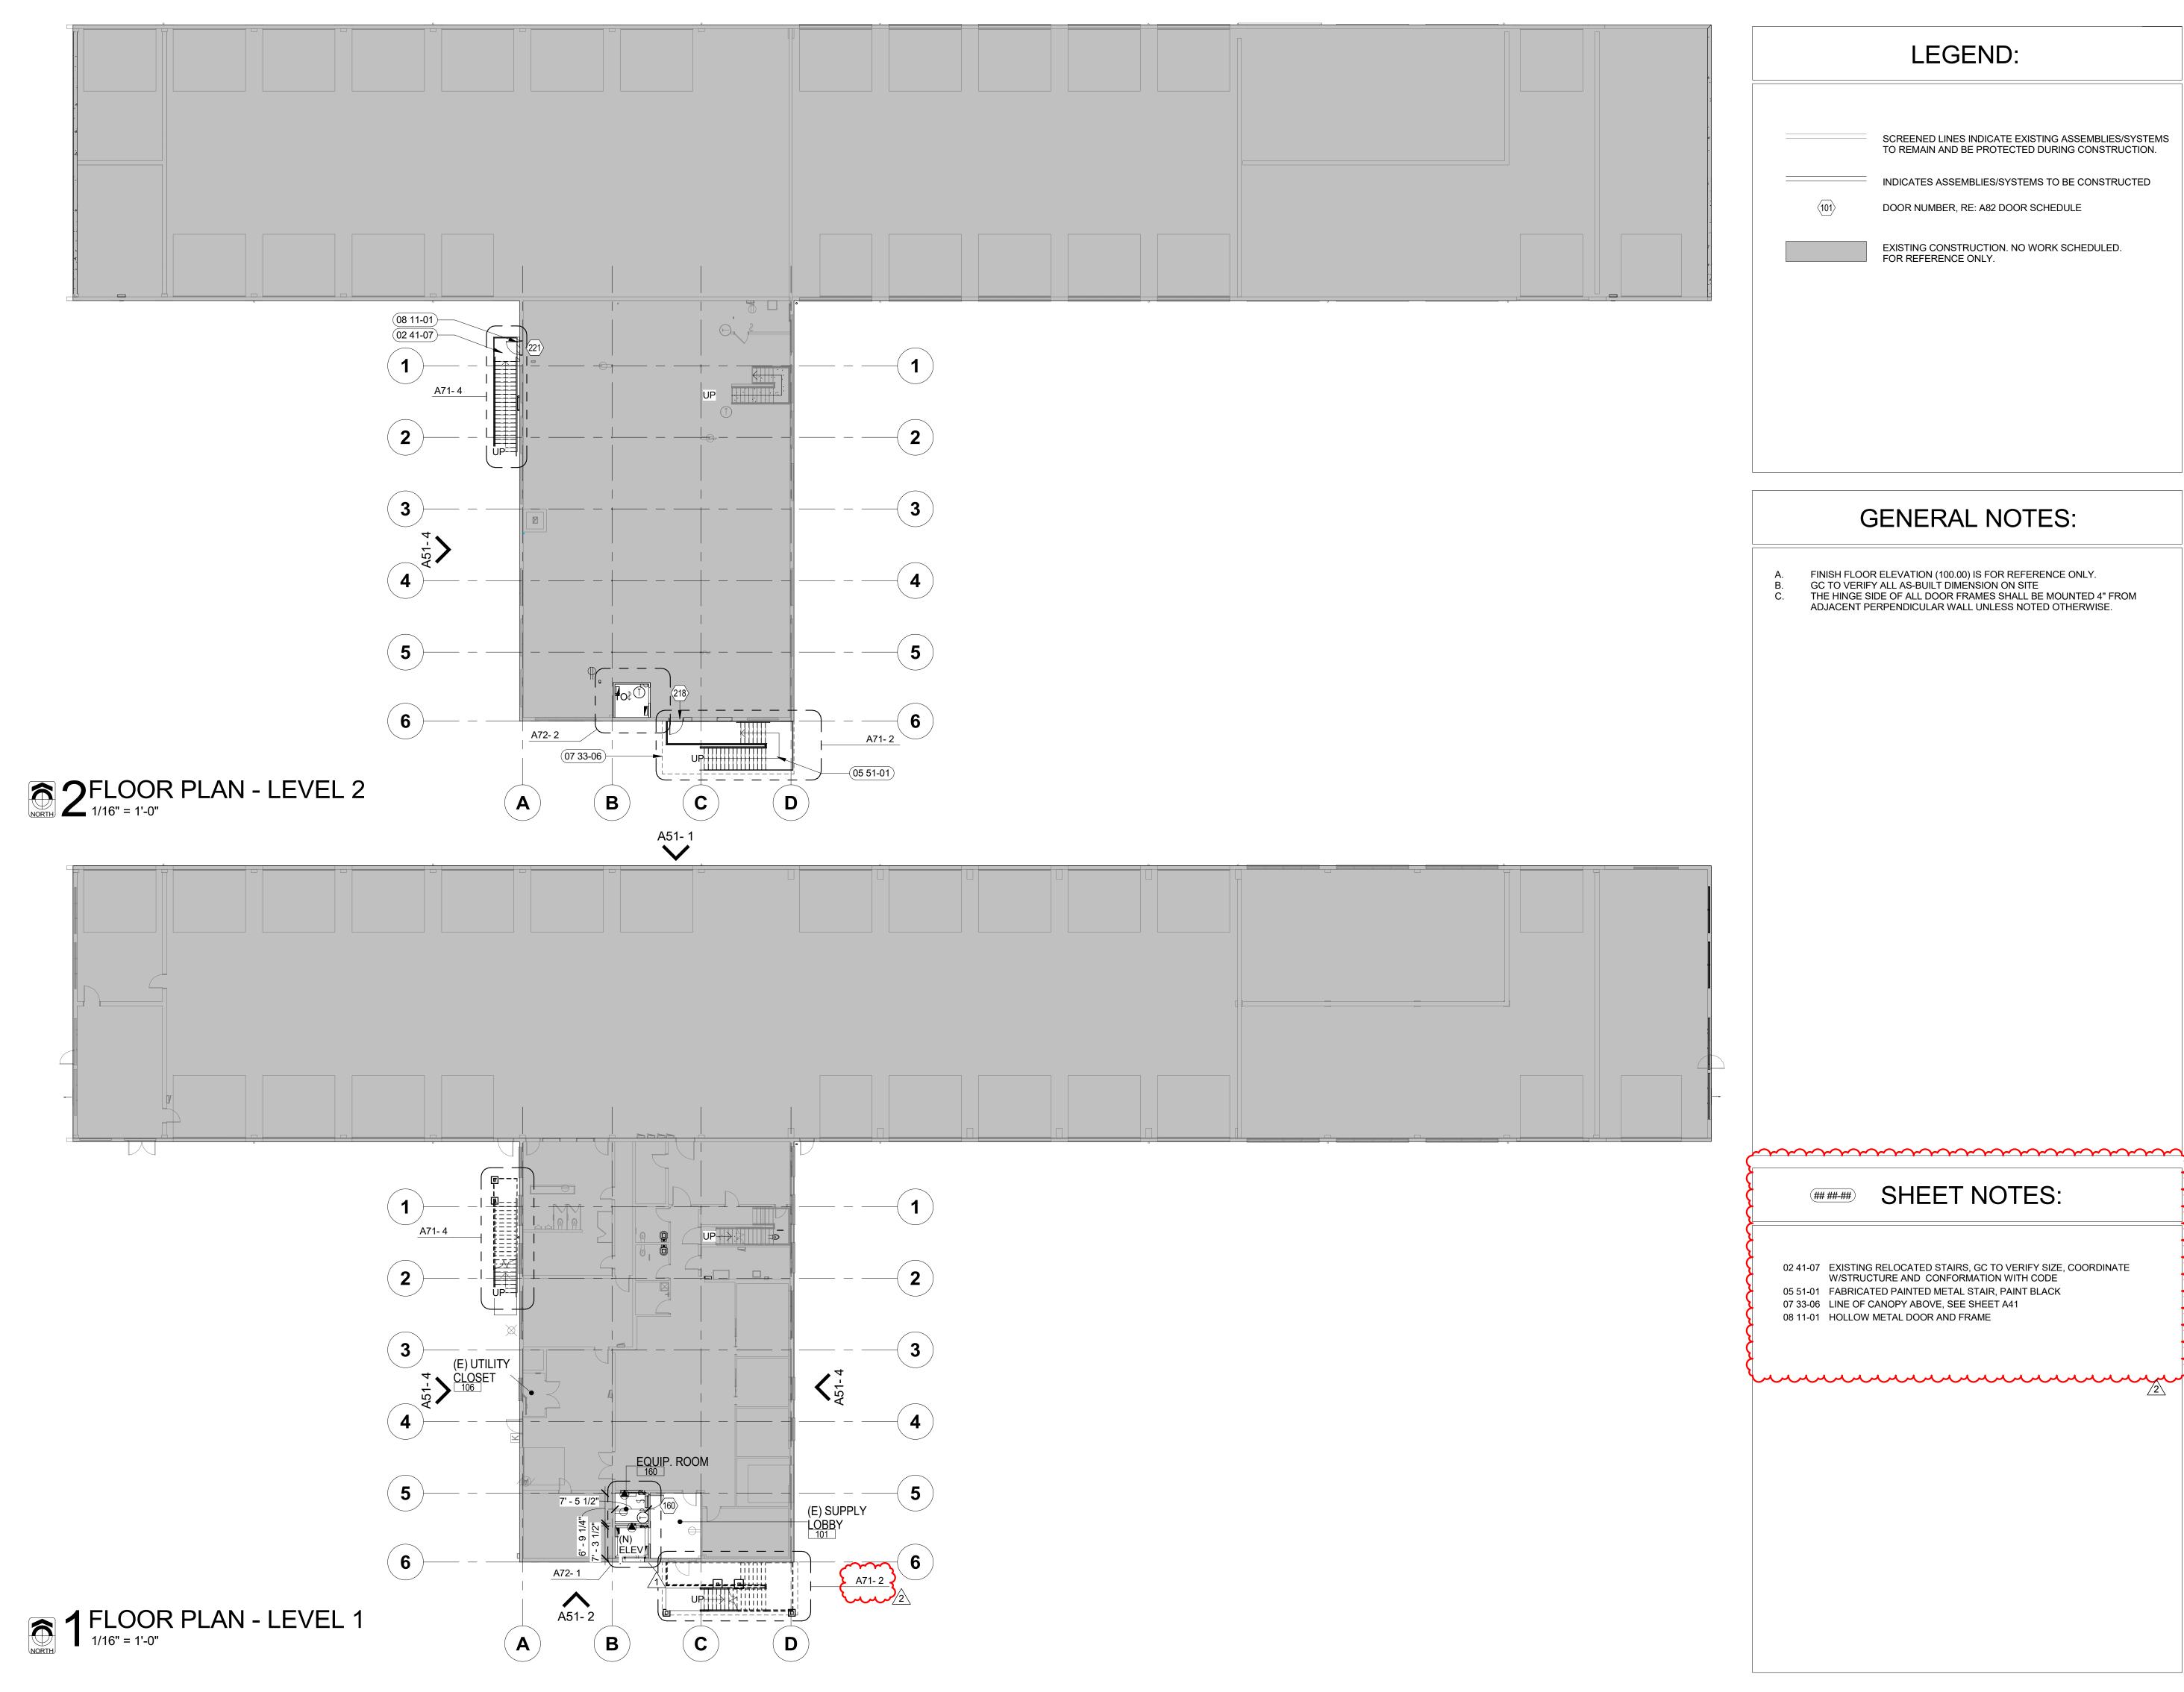

LEGEND:

SCREENED LINES INDICATE EXISTING ASSEMBLIES/SYSTEMS TO REMAIN AND BE PROTECTED DURING CONSTRUCTION.

INDICATES ASSEMBLIES/SYSTEMS TO BE CONSTRUCTED

DOOR NUMBER, RE: A82 DOOR SCHEDULE

EXISTING CONSTRUCTION. NO WORK SCHEDULED. FOR REFERENCE ONLY.

GENERAL NOTES:

FINISH FLOOR ELEVATION (100.00) IS FOR REFERENCE ONLY. GC TO VERIFY ALL AS-BUILT DIMENSION ON SITE THE HINGE SIDE OF ALL DOOR FRAMES SHALL BE MOUNTED 4" FROM ADJACENT PERPENDICULAR WALL UNLESS NOTED OTHERWISE.

02 41-07 EXISTING RELOCATED STAIRS, GC TO VERIFY SIZE, COORDINATE W/STRUCTURE AND CONFORMATION WITH CODE 05 51-01 FABRICATED PAINTED METAL STAIR, PAINT BLACK 07 33-06 LINE OF CANOPY ABOVE, SEE SHEET A41

SHEET NOTES:

08 11-01 HOLLOW METAL DOOR AND FRAME

REVISED E_BACK CHECK 1 03/27/24 2 Addendum 02

PROJECT

DRAWN

SHEET TITLE

BUILDING

IMPROVEMENT

PERMIT

SET


10-30-23

CHECKED LB


OVERALL PLANS

SHEET


ORIGINAL SHEET SIZE 24" x 36"

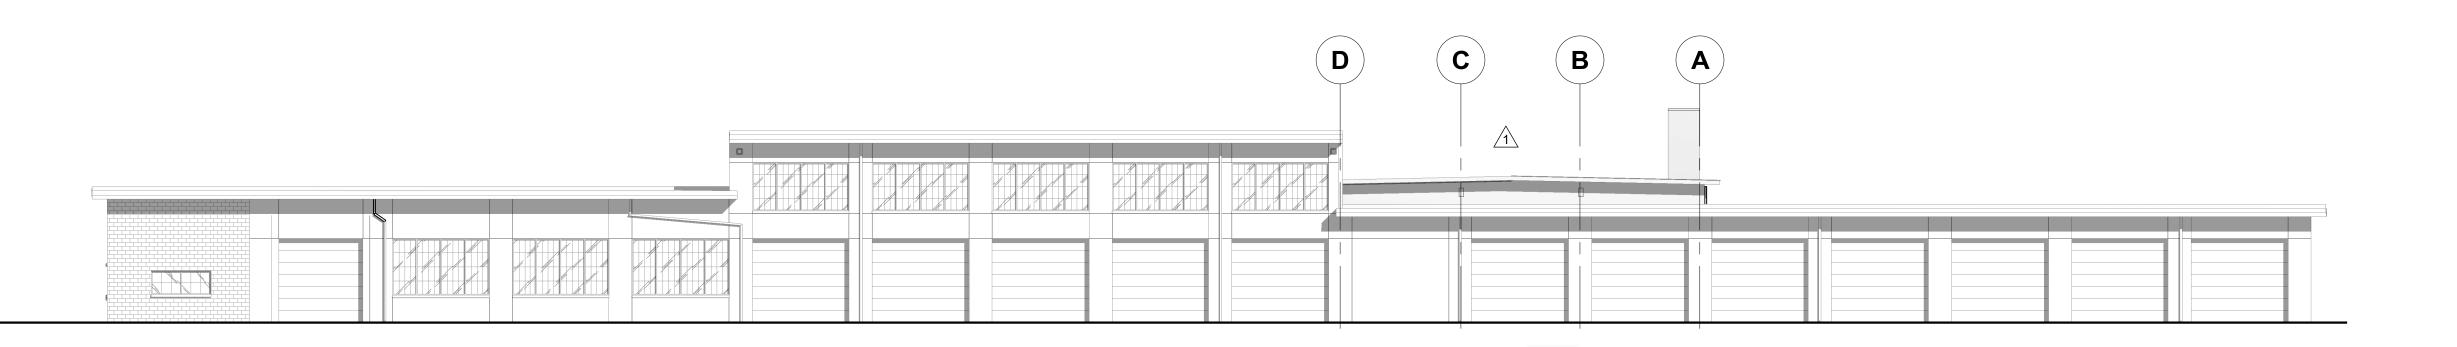


1 NORTH ELEVATION 1/16" = 1'-0"

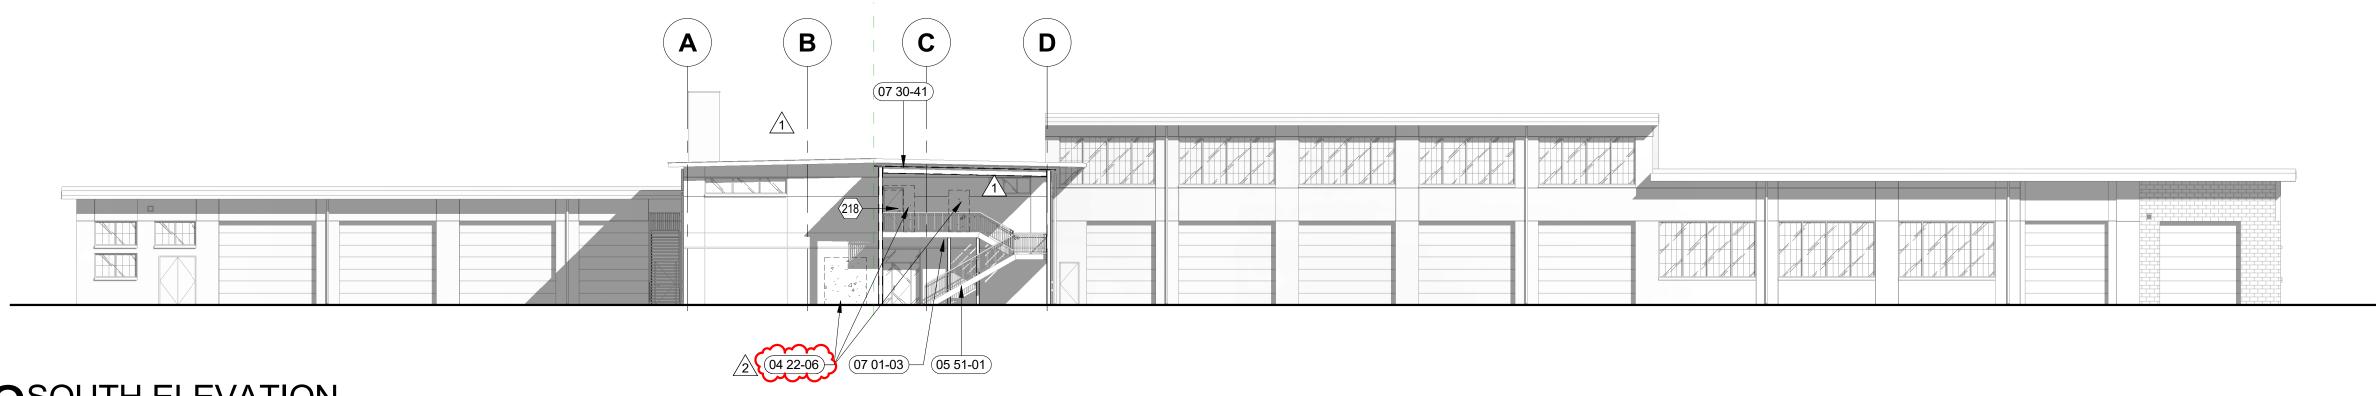

2 SOUTH ELEVATION
1/16" = 1'-0"

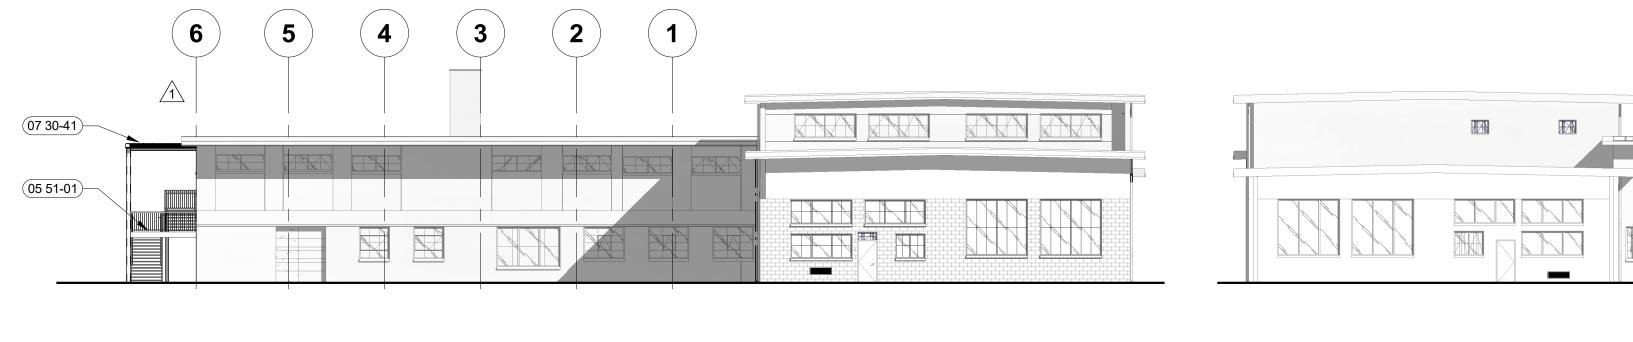

3EAST ELEVATION
1/16" = 1'-0"

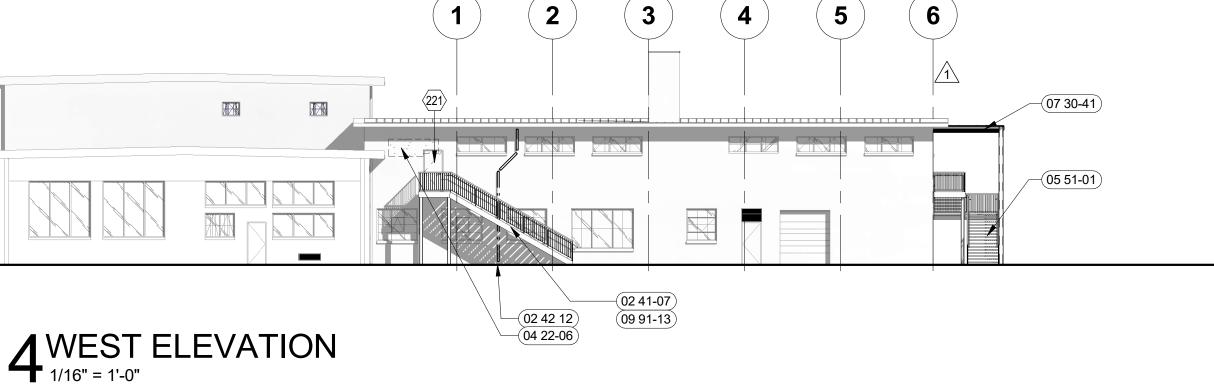

LEGEND:

DOOR NUMBER, RE: A82 DOOR SCHEDULE

00 00-01

SHEET NOTE, RE: SHEET NOTES LIST ON CURRENT PAGE

GENERAL NOTES:

- A. PROVIDE MATERIAL SAMPLES FOR OWNER/ARCHITECT'S APPROVAL.
- B. FINISHES ARE ALSO REQUIRED AT PORTIONS OF UNDERSIDE, INSIDE FACE OF PARAPETS, AND SOFFITS EXPOSED TO PUBLIC VIEW.
- C. THE REFERENCE ELEVATION MARKED WITH REPRESENTS VERTICAL HEIGHTS RELATIVE TO INTERIOR FLOOR DATUM ASSUMED AT 100'-0", CW/CIVIL FOR ACTUAL FLOOR ELEVATION.
- D. ALL MATERIAL SYMBOLS ARE FOR REPRESENTATION ONLY. CONTRACTOR IS RESPONSIBLE FOR DETERMINING PROPER COURSING, ETC.
- E. LOCATION FOR ADDRESS SIGNAGE TO BE INSTALLED AS REQUIRED AND APPROVEDBY THE CITY OF BOISE, ID.
- F. ALL ROOFTOP EQUIPMENT TO BE SCREENED BY WALLS OR EQUIPMENT
- G. COORDINATE LOCATION OF KNOXBOX WITH FIRE MARSHALL.
- H. ALL EXISTING EXTERIOR ELEMENTS TO REMAIN U.O.N.

SHEET NOTES:

02 41-07 EXISTING RELOCATED STAIRS, GC TO VERIFY SIZE, COORDINATE W/STRUCTURE AND CONFORMATION WITH CODE
02 42 12 EXISTING DOWNSPOUT, DO NOT DISTURB
04 22-06 INFILL/PATCH CONCRETE WALL WITH CMU. FINISH WITH SURFACE BONDING CEMENT SO THAT TEXTURE MATCHES AND ALIGNS WITH EXISTING CONCRETE. PAINT TO MACH EXISTING COLOR

05 51-01 FABRICATED PAINTED METAL STAIR, PAINT BLACK
07 01-03 PATCH AND REPAIR WHERE CANOPY AND STAIR DEMOLITION

07 01-03

PATCH AND REPAIR WHERE CANOPY AND STAIR DEMOLITION OCCURRED. PAINT TO MATCH ADJACENT SURFACES.

07 30-41

NEW ENTRY CANOPY ASSEMBLY: STANDING SEAM METAL ROOF PANELS O/ STRUCTURAL STEEL FRAMING. STANDING SEAM METAL ROOF PANELS: AEPSPAN DESIGN SPAN HP PANELS OR APPROVED EQUIVALENT, 18" PANEL SIZE, 24 GA., PREFINISHED COLOR TBD. ATTACH PANELS DIRECTLY TO OPEN FRAMING. PAINT CANOPY STEEL

STRUCTURE TO MATCH EXISTING GREEN PAINT COLOR.

09 91-13 PAINT EXISTING STAIR BLACK

LICENSED
ARCHITECT ORIGINAL DOCUMENT SIGNED
AR-984113 ARCHITECT ON FILE WITH THI
OWNER
ORIGINAL SIGNED BY:
JAMES A MARSH
STATE OF IDAHO
MAY 16, 2024
MAY 16, 2024

IROAD STREET
E, IDAHO
NE: 208-343-4635 • FAX: 208-343-1858

NE: 208-343-4635 • FAX: 208-343-1858

NE: 208-343-4635 • FAX: 208-343-1858

EDRAWINGS AND SPECIFICATIONS, AS
UMENTS OF SERVICE, ARE AND SHALL REMAIN THE
RETY OF THE ARCHITECT I ENGINEER WHETHER
ROJECT FOR WHICH THEY ARE MADE IS EXECUTED
IT. THESE DRAWINGS AND SPECIFICATIONS SHALL
E USED BY ANY PERSON OR ENTITY ON OTHER

THESE DRAWINGS AND SPE
INSTRUMENTS OF SERVICE,
RISTRUMENTS OF THE ARCHITE
B3702
PROJECT FOR WHICH THE PROJECT FOR WHICH THE PROJECT FOR WHICH THE PROJECTS, FOR ADDITIONS
COMPLETION OF THIS PROJECTS, CONSENT OF THE WIND THE WIND THIS PROJECTS.

200 BROAD STRE BOISE, ID 83 635 • FAX (208) 343-1

GAKDEN20(208) 343-4635 • F

DIST. 3 BLD
WEST CHINDEN B
HAA

BUILDING IMPROVEMENT PERMIT SET

PROJECT DATE
23002 10-30-23

DRAWN CHECKED
SS LB

03/27/24

REVISED
1 E_BACK CHECK 1
2 Addendum 02


ddendum 02 05/16/24

SHEET TITLE **EXTERIOR**


ELEVATIONS

SHEET


A51
ORIGINAL SHEET SIZE 24" x 36"

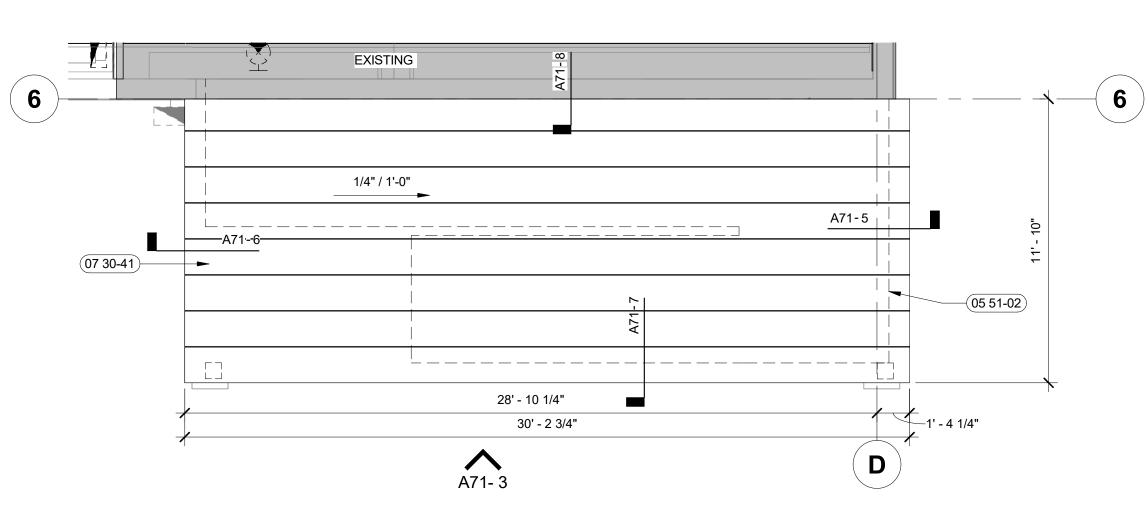


1 ENLARGED CANOPY PLAN 1/4" = 1'-0"

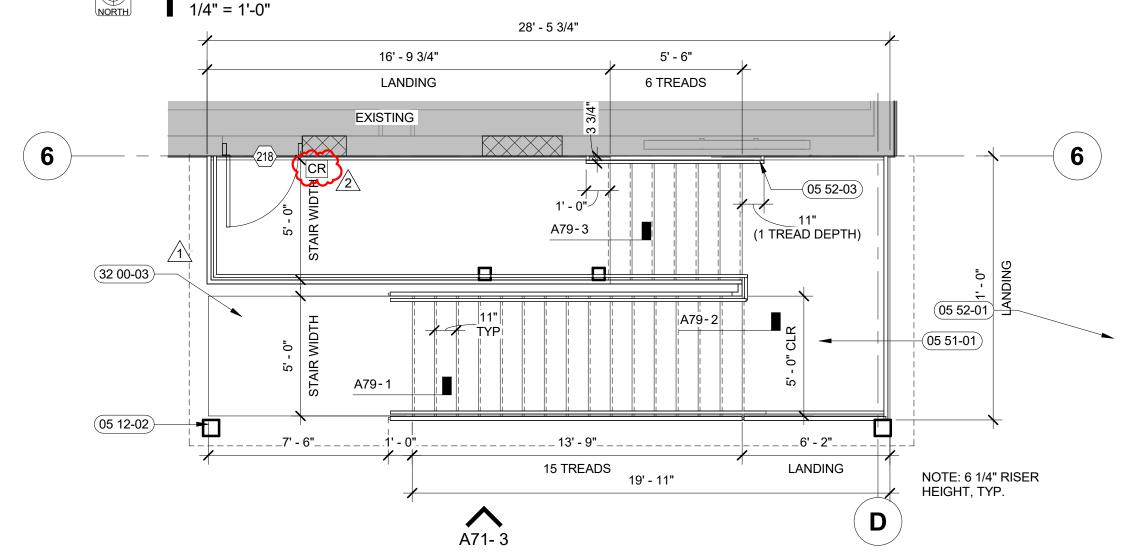

2ENLARGED EXTERIOR STAIR 2 PLAN - LEVEL 2

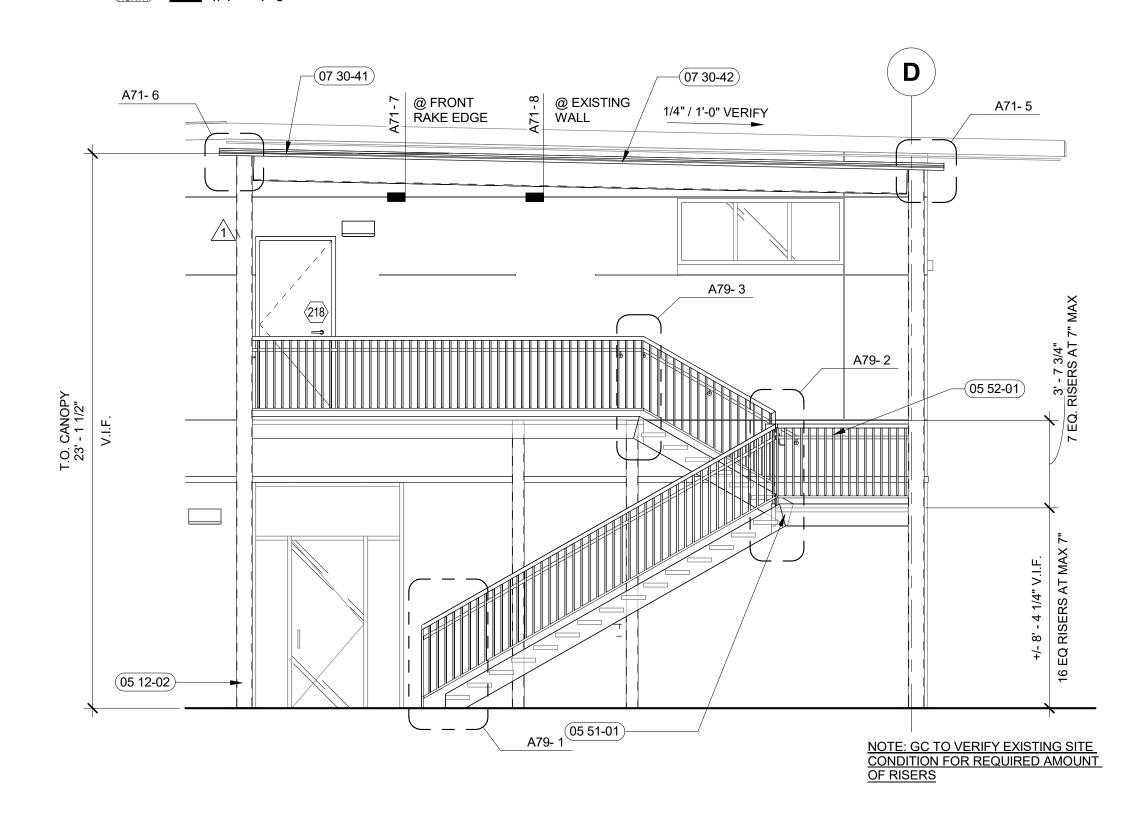


3CANOPY AND STAIR 2 ELEVATION

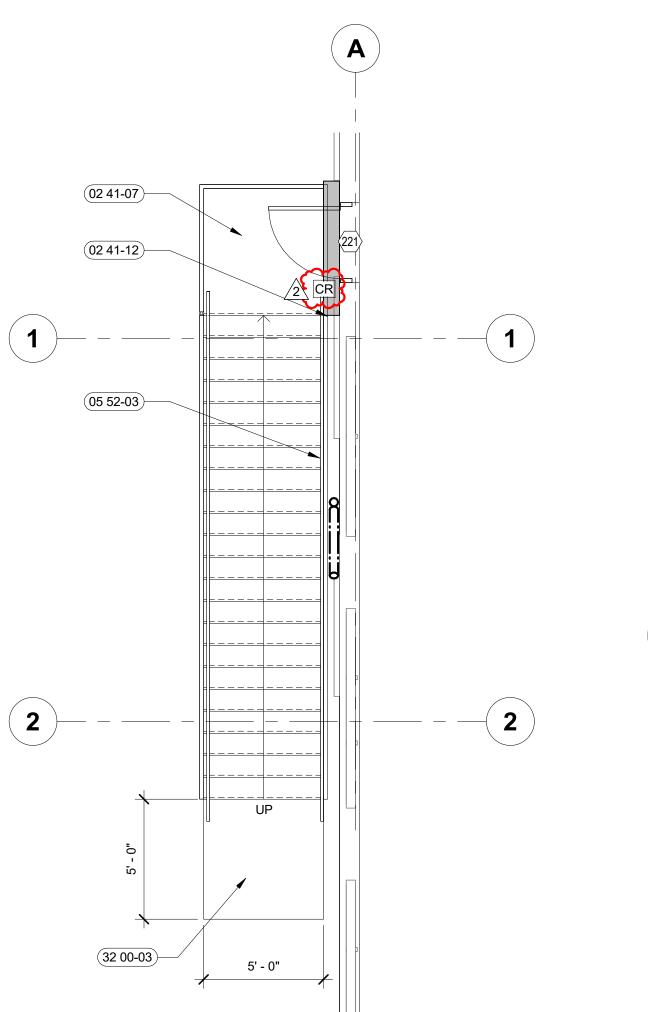

4 RELOCATED STAIR 1 PLAN
1/4" = 1'-0"

FASTENERS

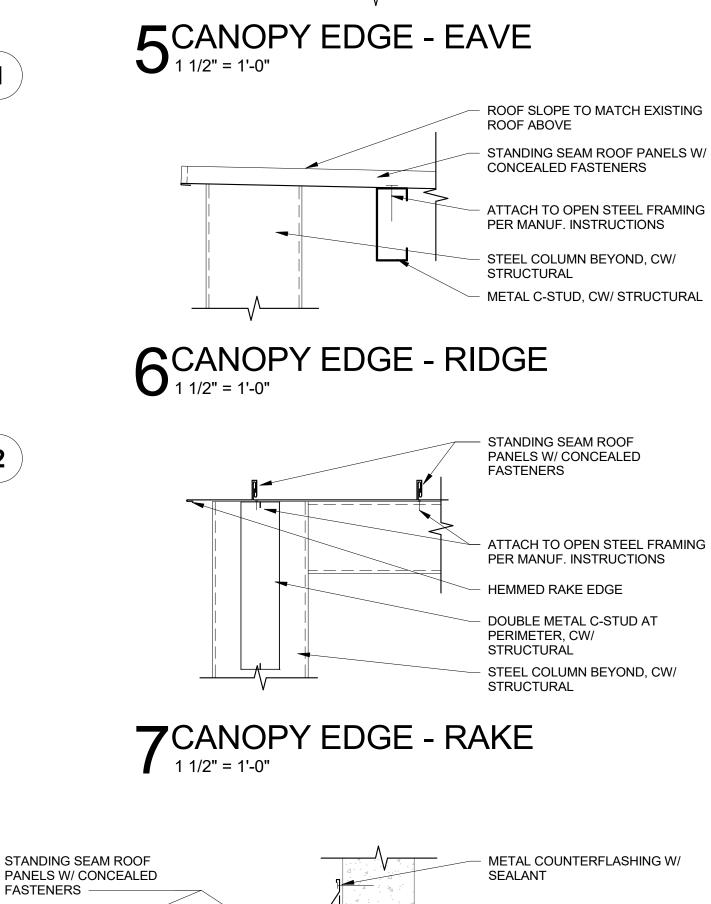

ROOF SLOPE TO MATCH EXISTING

STANDING SEAM ROOF PANELS W/ CONCEALED FASTENERS

ATTACH TO OPEN STEEL FRAMING

METAL C-STUD, CW/ STRUCTURAL

PER MANUF. INSTRUCTIONS

STEEL COLUMN BEYOND, CW/

ROOF ABOVE

STRUCTURAL

8CANOPY EDGE - EXISTING WALL

METAL BASE FLASHING

J-CHANNEL AT WALL EDGE

ATTACH TO OPEN STEEL FRAMING PER MANUF. INSTRUCTIONS

METAL C-STUD, CW/ STRUCTURAL

STEEL CHANNEL AT EXISTING

WALL, CW/ STRUCTURAL

EXSTING CONC. WALL

LEGEND:

SCREENED LINES INDICATE EXISTING ASSEMBLIES/SYSTEMS TO REMAIN AND BE PROTECTED DURING CONSTRUCTION. INDICATES ASSEMBLIES/SYSTEMS TO BE CONSTRUCTED DOOR NUMBER, RE: A82 DOOR SCHEDULE WINDOW TYPE, RE: A82 WINDOW TYPES W01 T.O.W. WALL TYPE, RE: A21 FOR WALL TYPES WITH VARIABLE HEIGHT, SEE TOP OF WALL ELEVATION XXX'-XX" 00 00-01 SHEET NOTE, RE: SHEET NOTES LIST ON CURRENT PAGE INTERIOR ELEVATIONS SEE DWG. #1 @ SHT. I51, I52, I53

GENERAL NOTES:

- DIMENSION IS NOT SHOWN ON INTERIOR SHEETS UNLESS INTERIOR SPECIFIC. REFER ARCHITECTURAL DRAWINGS FOR DIMENSIONS.
- FIELD VERIFY ALL DIMENSIONS PRIOR TO FABRICATION / ORDERING. PRIME AND PAINT ALL EXPOSED STEEL INCLUDING UNDERSIDE OF

CANOPY ROOFING.

SHEET NOTES:

02 41-07 EXISTING RELOCATED STAIRS, GC TO VERIFY SIZE, COORDINATE W/STRUCTURE AND CONFORMATION WITH CODE 02 41-12 FILL GAP BETWEEN STAIR LANDING AND WALL AS NECESSARY STRUCTURAL STEEL COLUMN, RE: STRUCTURAL DRAWINGS. 05 12-02 05 51-01 FABRICATED PAINTED METAL STAIR, PAINT BLACK 05 51-02 LINE OF NEW STAIRS BELOW 05 52-01 GUARDRAIL W/ ATTACHED HANDRAIL. 05 52-03 WALL MOUNTED HANDRAIL, PAINTED TO MATCH STAIR FRAMING 07 30-41 NEW ENTRY CANOPY ASSEMBLY: STANDING SEAM METAL ROOF PANELS O/ STRUCTURAL STEEL FRAMING. STANDING SEAM METAL ROOF PANELS: AEPSPAN DESIGN SPAN HP PANELS OR APPROVED EQUIVALENT, 18" PANEL SIZE, 24 GA., PREFINISHED COLOR TBD. ATTACH PANELS DIRECTLY TO OPEN FRAMING. PAINT CANOPY STEEL STRUCTURE TO MATCH EXISTING GREEN PAINT COLOR. 07 30-42 SLOPE CANOPY ROOF TO MATCH EXISTING ROOF SLOPE ABOVE. 32 00-03 PROVIDE CONCRETE LANDING WITH 2% MAXIMUM CROSS SLOPE.

BUILDING IMPROVEMENT PERMIT SET

PROJECT DATE 23002 10-30-23 CHECKED DRAWN LB

03/27/24


REVISED E_BACK CHECK 1 2 Addendum 02

SHEET

SHEET TITLE


STAIRS & **CANOPY**

A71 ORIGINAL SHEET SIZE 24" x 36"

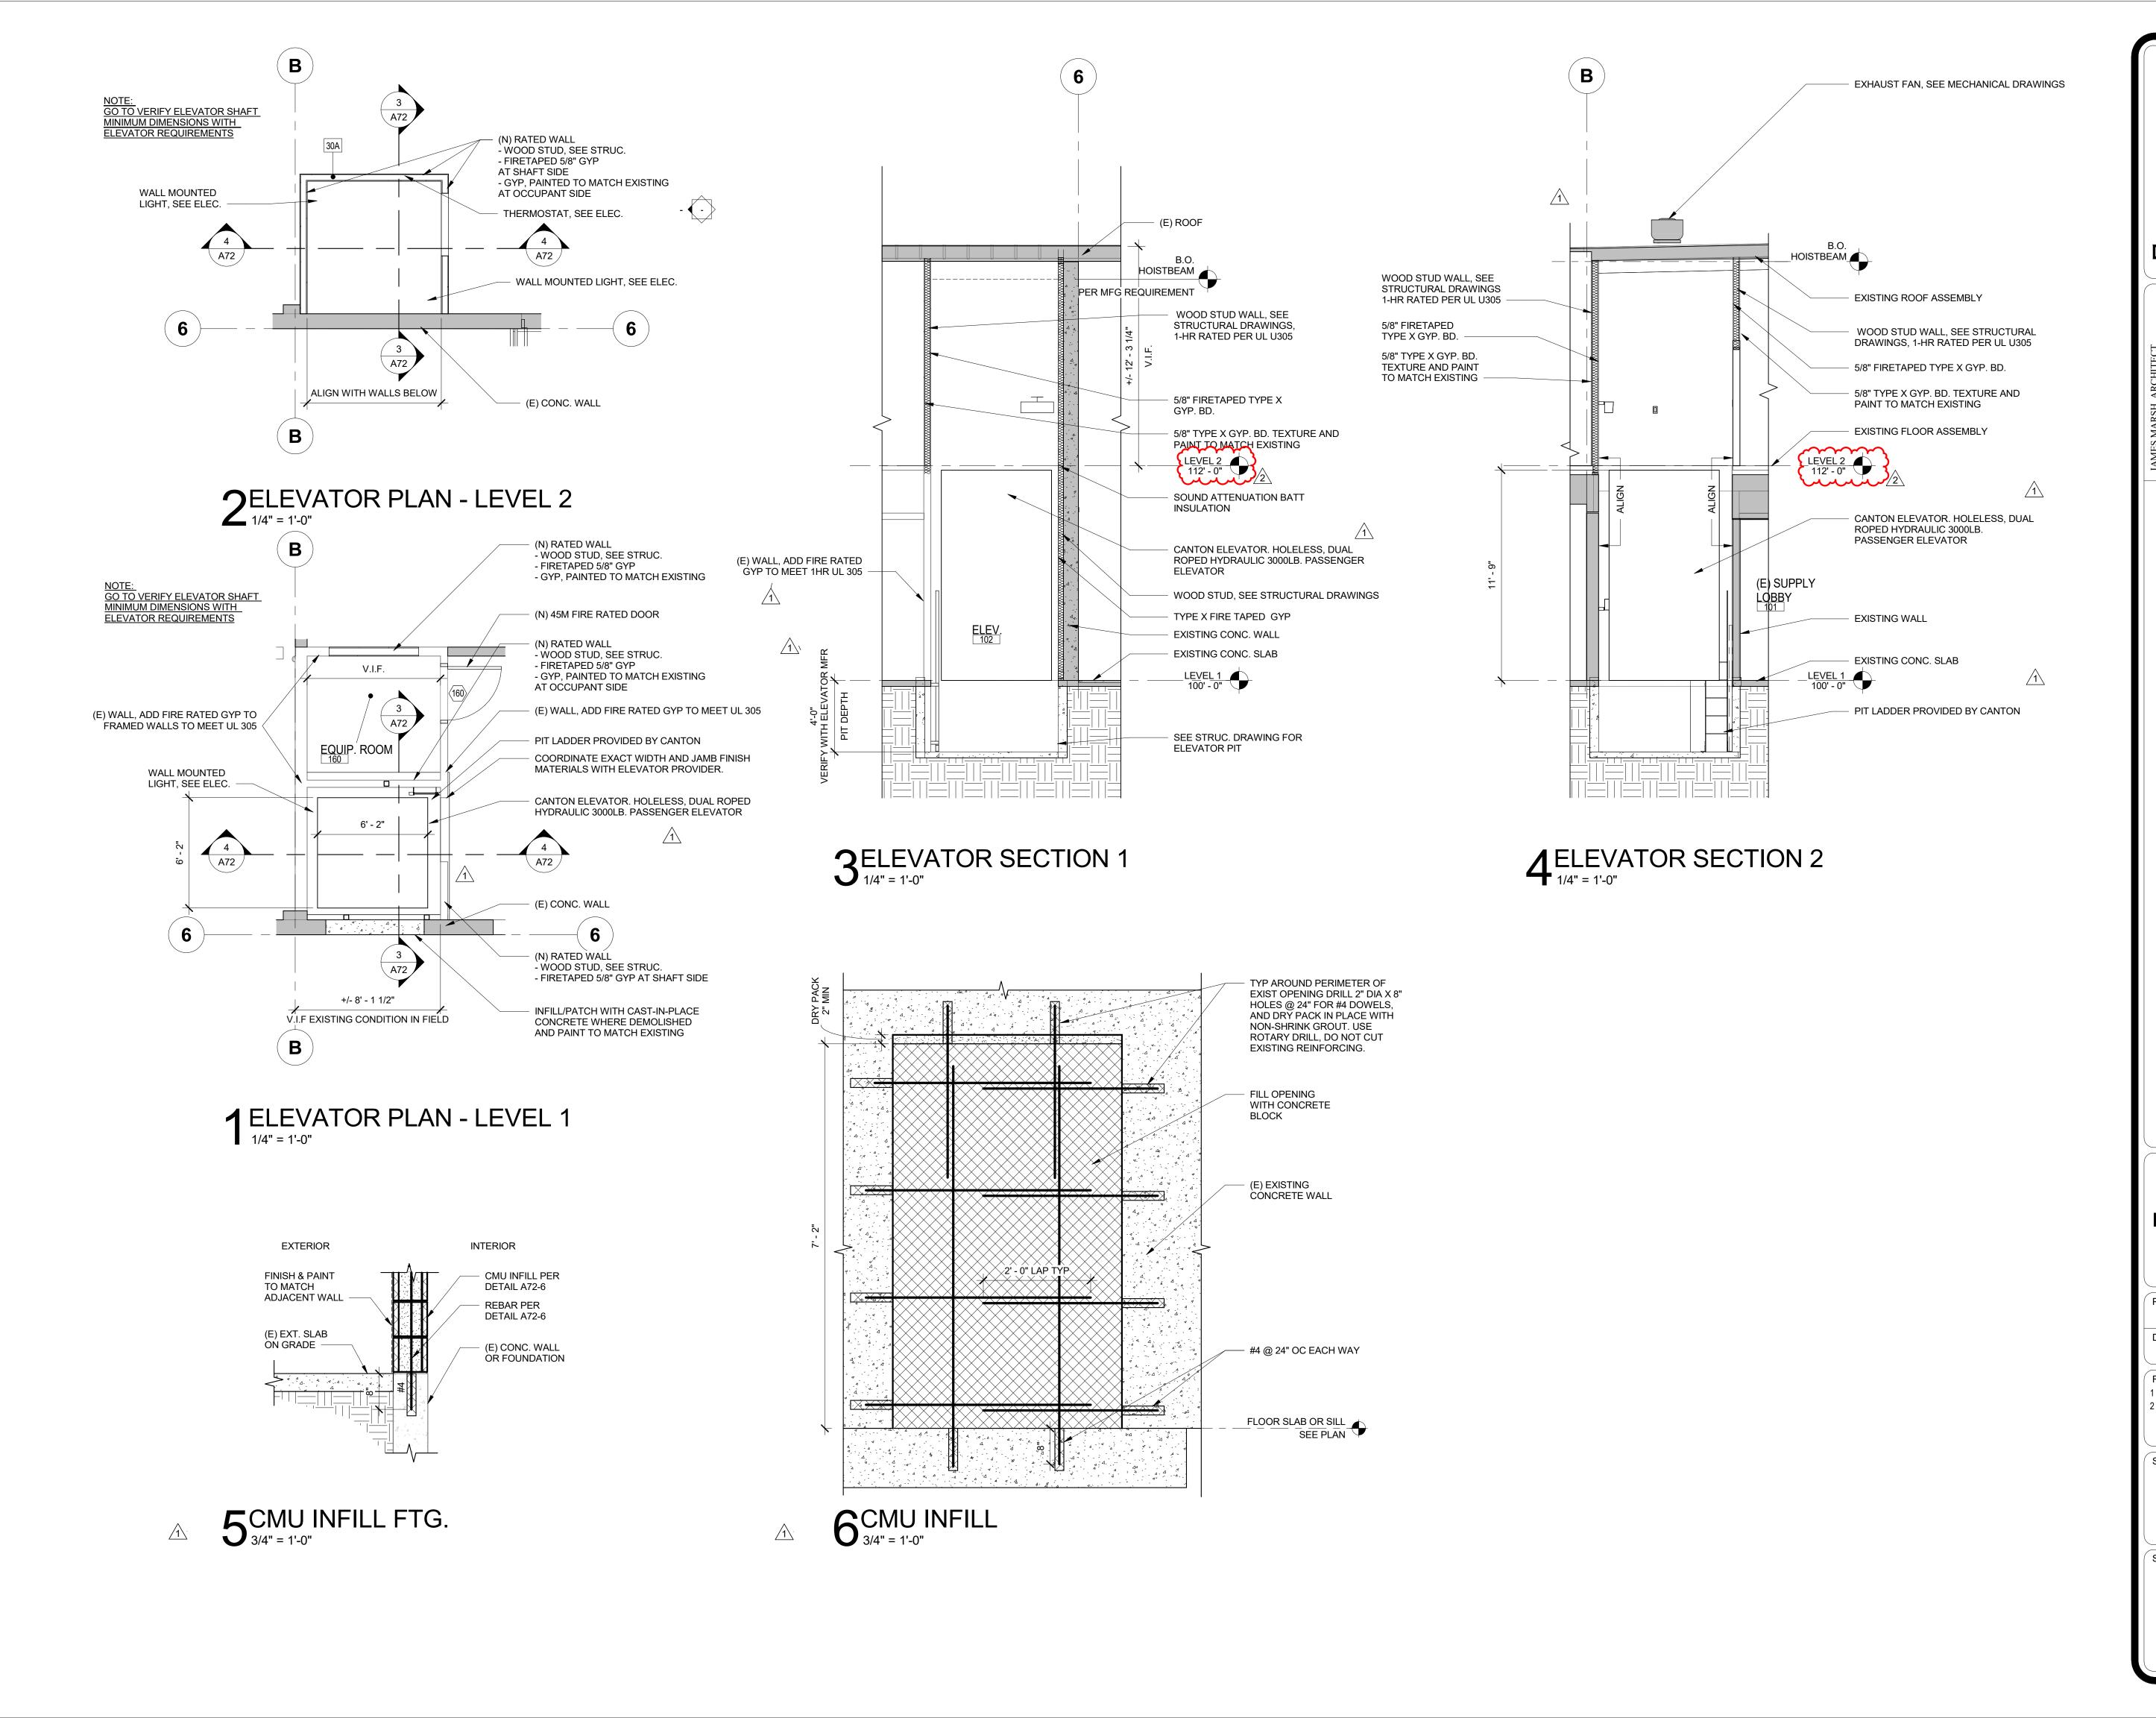



5/16/2024 10·29·56 AM

BUILDING IMPROVEMENT PERMIT SET PROJECT 10-30-23 23002 DRAWN CHECKED SS LB REVISED 1 E_BACK CHECK 1 2 Addendum 02 SHEET TITLE **ELEVATOR DETAILS** SHEET ORIGINAL SHEET SIZE 24" x 36"

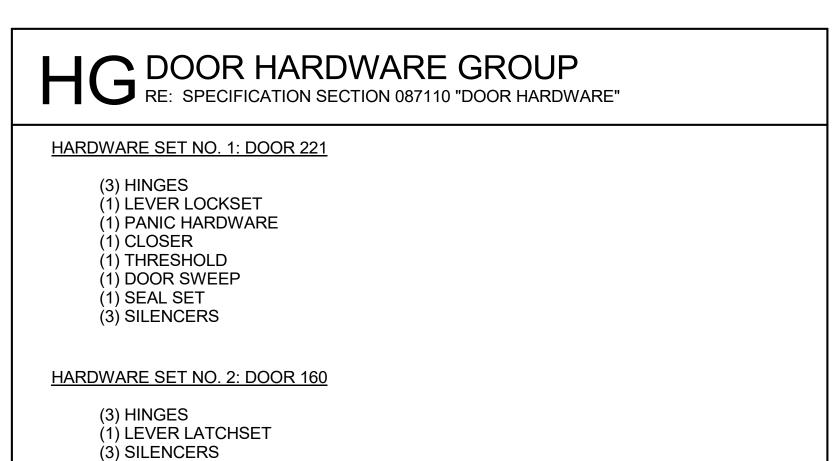


10DOOR SCHEDULE												
	From Room:			FRAME	DOOR							
NUMBER	Name	NUMBER	TYPE	TYPE	WIDTH	HEIGHT	THICKNESS	CONSTRUCTION TYPE	1	COMMENTS	HARÇ	WARE SET
160	EQUIP. ROOM	160	B	НМ	3' - 0"	7' - 0"	1 3/4"	SOLID CORE WOOD	45M I	FIRE RATING		2 }
218	EXISTING SECOND LEVEL	200 /	2 A	НМ	3' - 0"	7' - 0"	1 3/4"	INSULATED METAL				1 }
221	EXISTING SECOND LEVEL	200	Α	НМ	3' - 0"	7' - 0"	1 3/4"	INSULATED METAL				1 3
	1						1					(m)

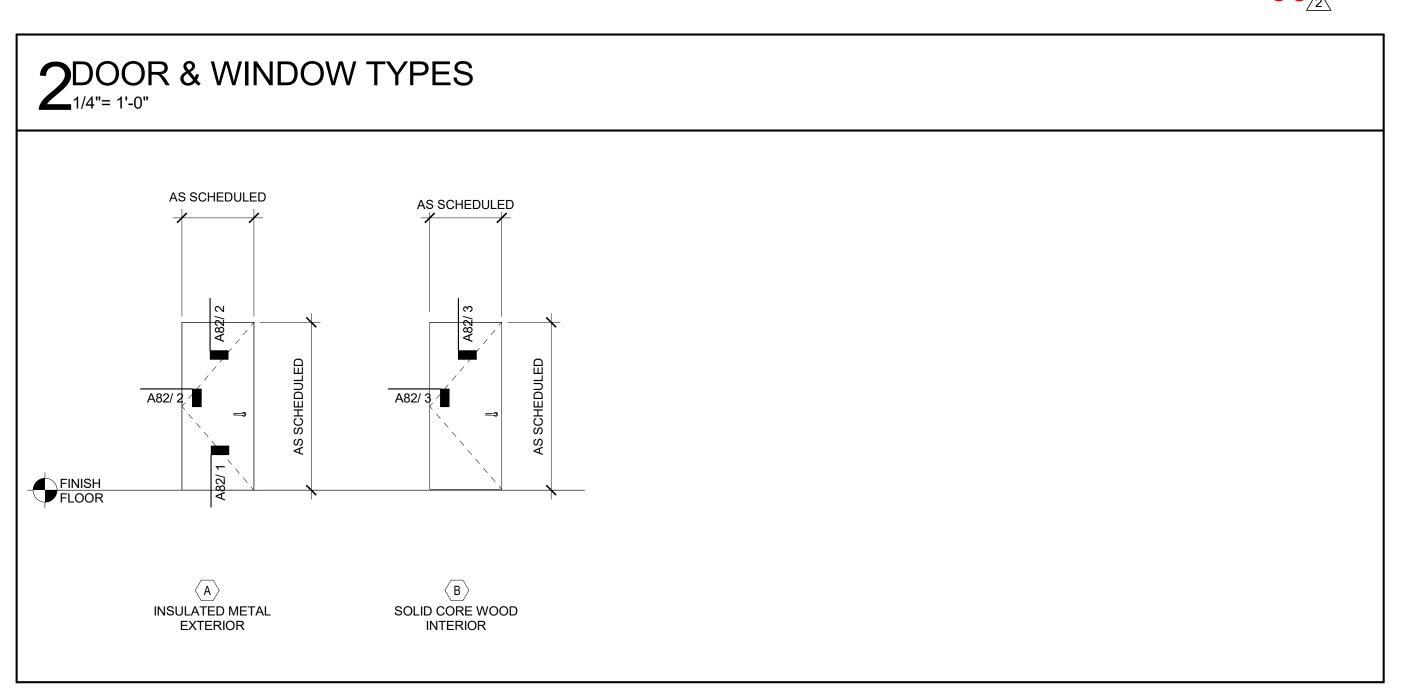


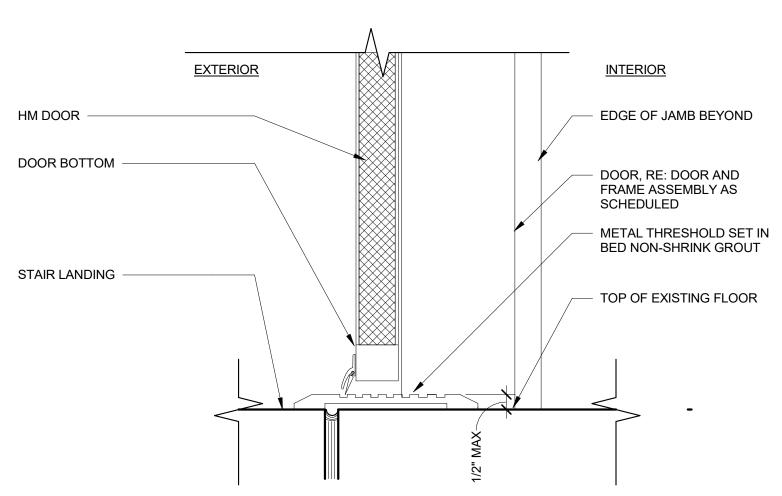

1 EXTERIOR DOOR THRESHOLD

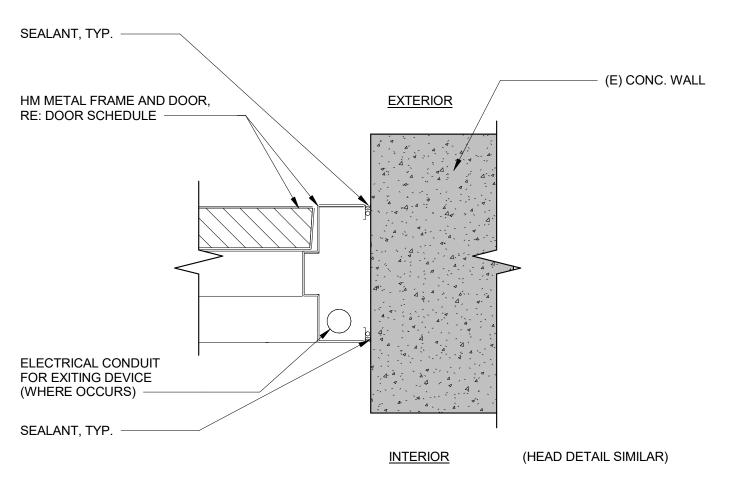

2EXTERIOR DOOR JAMB

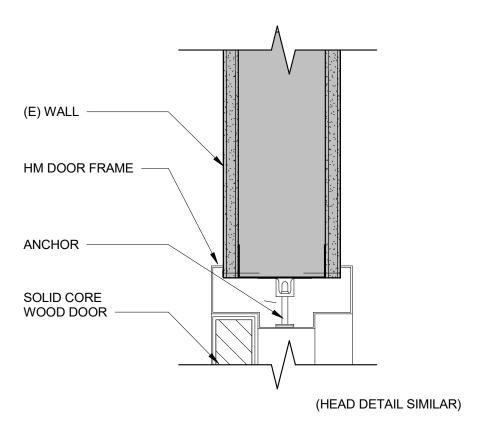


3INT DOOR JAMB

DOOR GENERAL NOTES:

- VERIFY ROUGH OPENING IN FIELD.
- INSTALL DOORS AND FRAMES PER MANUFACTURER'S REQUIREMENTS.
- ALL EXITS SHALL BE OPENABLE FROM THE INSIDE WITHOUT THE USE OF
- 4. OPENING FORCE FOR INTERIOR SIDE-SWINGING DOORS WITHOUT CLOSERS SHALL NOT EXCEED A 5- POUND FORCE

A KEY OR ANY SPECIAL KNOWLEDGE OR EFFORT.

- 5. FOR OTHER SIDE- SWINGING DOOR, THE DOOR LATCH SHALL RELEASE WHEN SUBJECTED TO A 15-POUND FORCE. THE DOOR SHALL BE SET IN MOTION WHEN SUBJECTED TO A 30-POUND FORCE. THE DOOR SHALL SWING TO A FULL-OPEN POSITION WHEN SUBJECTED TO A 15-POUND FORCE. FORCES SHAL LBE APPLIED TO THE LATCH SIDE
- 6. DOOR HANDLES, PULLS, LATCHES, LOCKS AND OTHER OPERATING DEVICES SHALL NOT REQUIRE TIGHT GRASPING, TIGHT PINCHING OR TWISTING OF THE WRIST TO OPERATE.
- DOOR HANDLES, PULLS, LATCHES, LOCKS AND OTHER OPERATING DEVICES SHALL BE INSTALLED 34 INCHSE MINIMUM AND 48 INCHES MAXIMUM ABOVE THE FINISHED FLOOR. LOCKS ONLY USED FOR SECUIRTY PURPOSES AND NOT USED FOR NORMAL OPERATION ARE PERMITTED AT ANY HEIGHT
- 8. THE UNLATCHING OF ANY DOOR OR LEAF SHALL NOT REQUIRE MORE THAN ONE OPERATION.

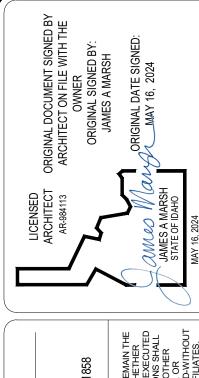

LDG. IMPROVEMENT EN BLVD GARDEN CITY, ID

BUILDING IMPROVEMENT PERMIT SET

PROJECT 10-30-23 CHECKED DRAWN LB

05/16/24

REVISED 1 E_BACK CHECK 1 03/27/24 2 Addendum 02

DOOR & **WINDOW** SCHEDULES

ORIGINAL SHEET SIZE 24" x 36"