


PRESTRESSED GIRDER SCHEDULE


GIRDERS		PRESTRESS FORCE ~ KIPS		PRESTRESS LOSSES ~ KSI		CONCRETE STRENGTH ~ KSI		GIRDER DIMENSIONS						END DETAIL		C.G. OF STRAND			
NO.	LOCATION	INITIAL BEFORE LOSSES	FINAL AFTER LOSSES	IMMEDIATE LOSSES	FINAL TOTAL LOSSES	AT RELEASE f'ci	AT 28 DAYS f'c	(A)	(B)	(C)		(D)		(E)	(F)	LEFT	RIGHT	(b)	(a)
										LEFT	RIGHT	LEFT	RIGHT						

REINFORCEMENT DIAGRAM			
MARK	SIZE	GRADE	SKETCH
G1*	#5	60	
G2*	#4	60	
G3*	#3	60	
G4	#5	60	
G4A	#5	60	
G5	#6	60	
G5A	#6	60	
G6	#4	60	
G7	#3	60	
G7A	#3	60	
G8	#8	60	
G9	#4	60	
G9A	#4	60	
G10*	#4	60	
G11	#3	60	

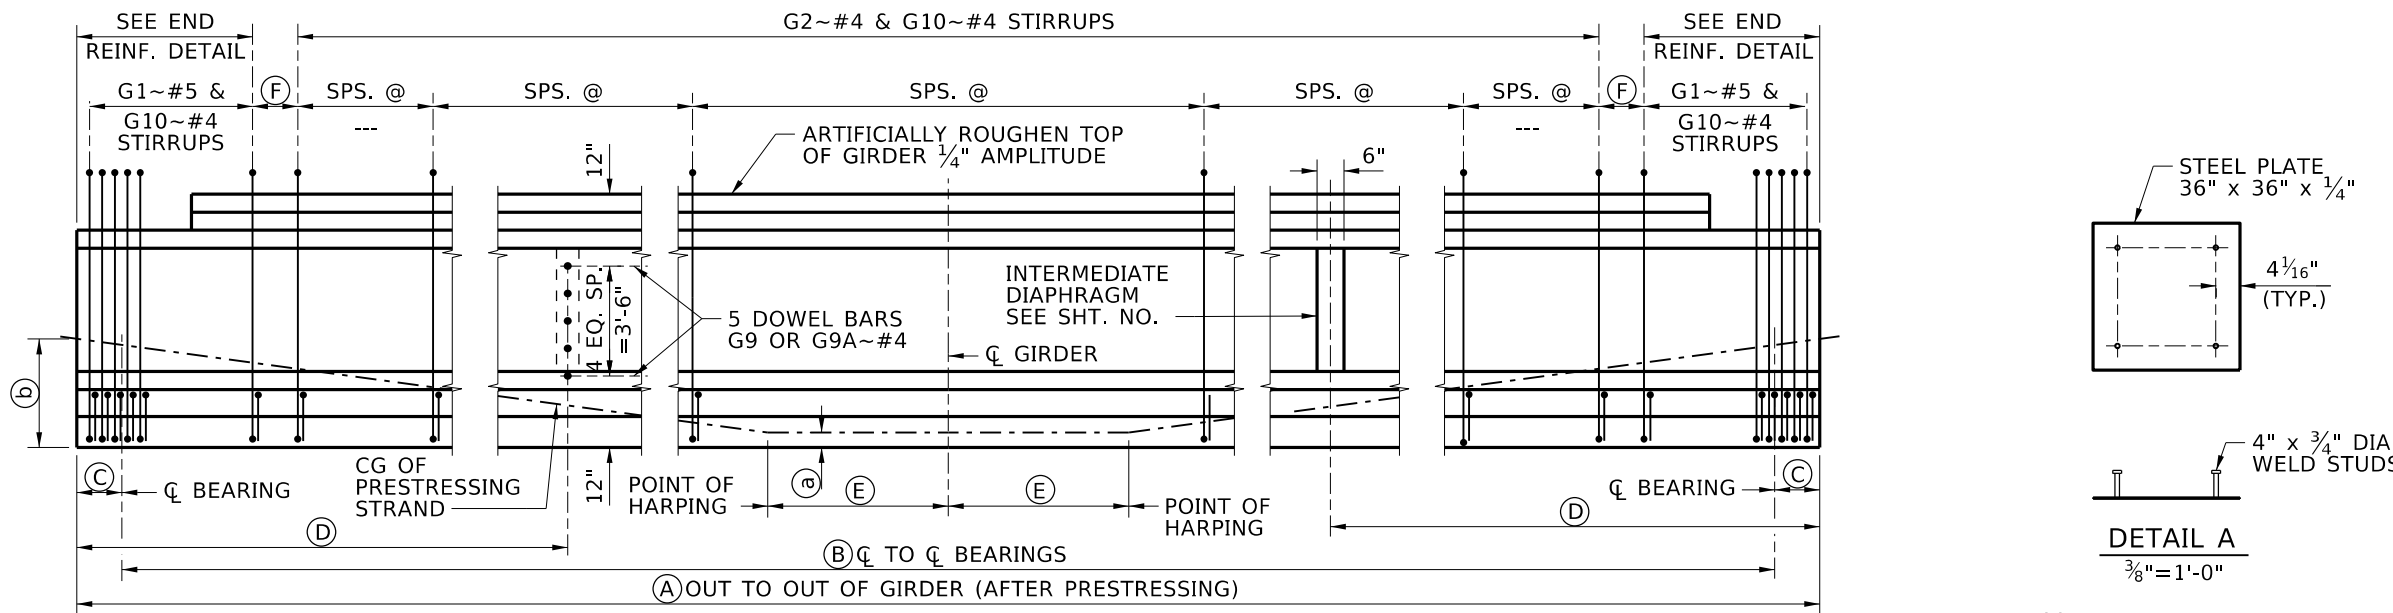


GIRDER ELEVATION AND STIRRUP LAYOUT

NTS

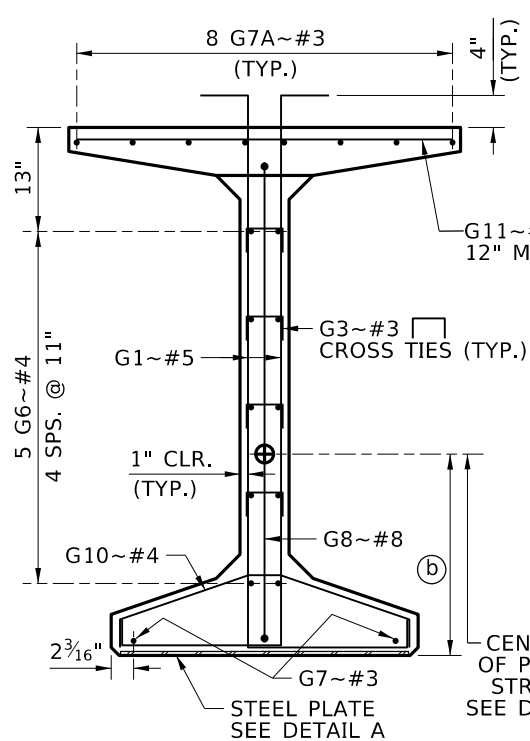


SECTION AT END OF GIRDER

1/2"=1'-0"

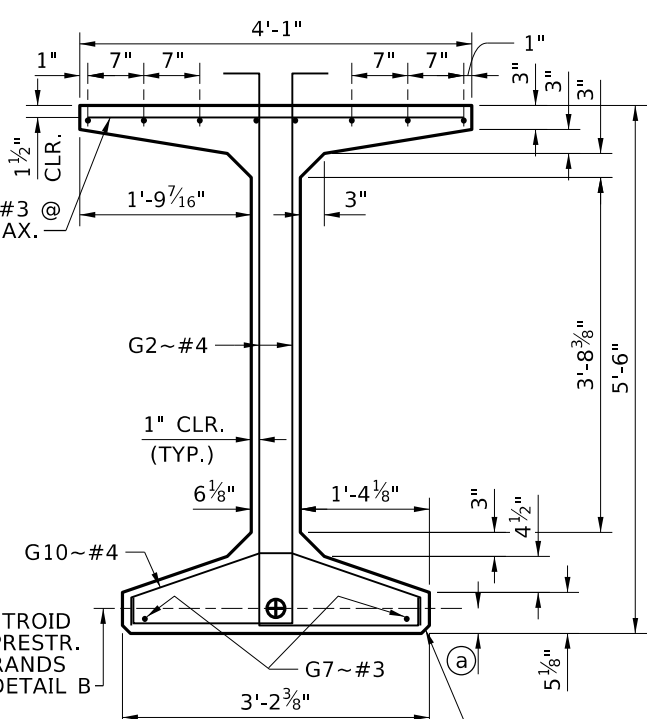


SECTION AT Q SPAN

1/2"=1'-0"

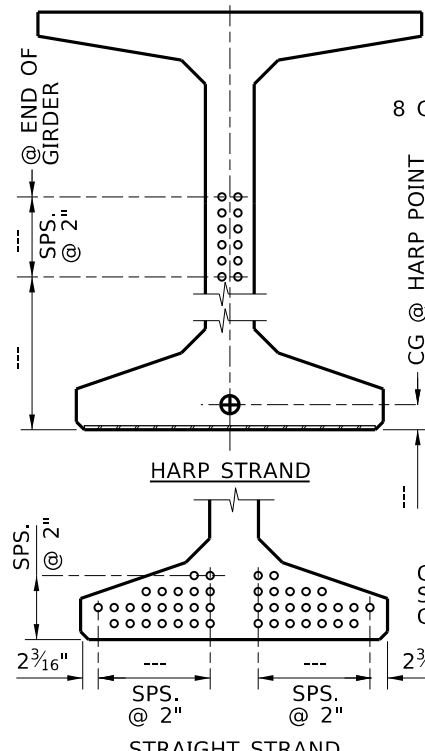

DETAIL B

1/2"=1'-0"

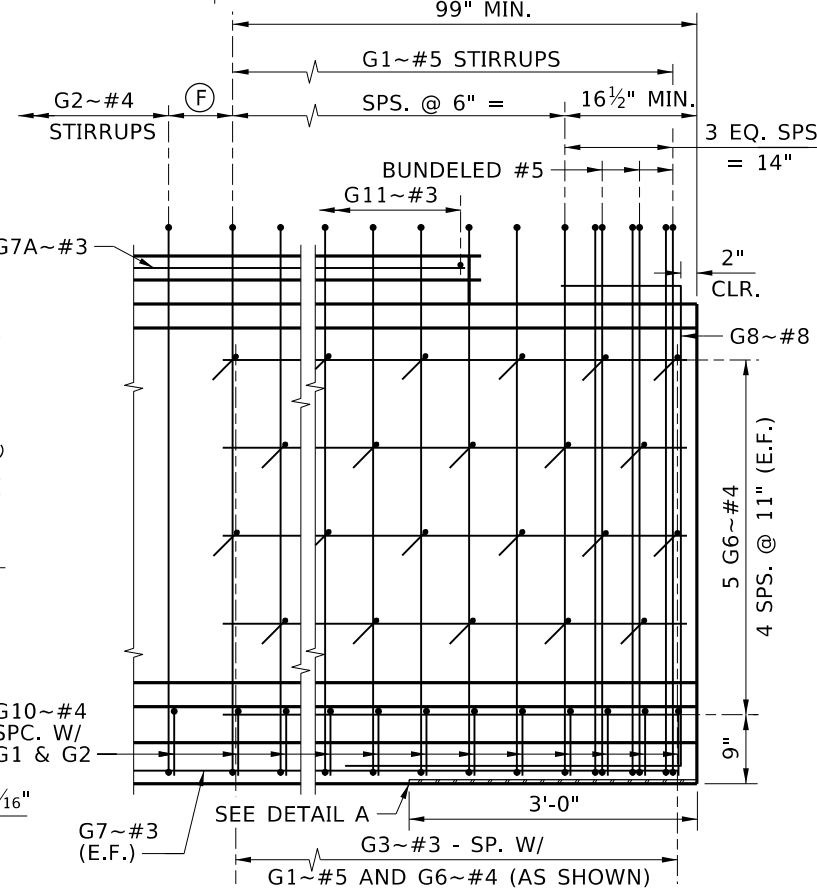

END REINFORCEMENT DETAIL

1/2"=1'-0"

- NOTES
1. DIMENSIONS TO STIRRUPS AND DOWEL BARS ARE GIVEN AT Q OF GIRDER.
 2. SEE PRESTRESSED GIRDER GENERAL DETAILS AND PRESTRESSED WF GIRDER DETAILS SHEETS FOR NOTES, DIAPHRAGM DOWEL DETAILS, END DETAILS AND DEFLECTION DATA.
 3. BEND DETAILS IN ACCORDANCE WITH LATEST ACI STANDARD PRACTICE.
- * STIRRUP AND TIE HOOK BEND DIMENSIONS. STIRRUPS AND TIES MUST HAVE A MINIMUM 1" COVER OUTSIDE OF BARS.

GIRDER WEIGHT..... 911 LB/FT

REVISIONS			
NO.	DATE	BY	DESCRIPTION

DESIGNED	SCALES SHOWN ARE FOR 11" X 17" PRINTS ONLY CADD FILE NAME Standards/Bridge Standard Drawings B05_3L.DGN DRAWING DATE: OCT 2023
DESIGN CHECKED	
DETAILED	
DWG. CHECKED	
CORRECTIONS	

IDAHO TRANSPORTATION DEPARTMENT

 YOUR Safety→YOUR Mobility→YOUR Economic Opportunity
 APPROVED BY: BRIDGE ENGINEER **MICHAEL T. JOHNSON** DATE:

ENGLISH
 PROJECT NO.

WF66G PRESTRESSED GIRDER
 BRIDGE LRFD DESIGN MANUAL, B5.3L

BRIDGE PLANS	
BRIDGE KEY NO.	
COUNTY	KEY NO.
BRIDGE DWG. NO.	SHEET OF